

Planning Commission Meeting Agenda

Tuesday, September 3, 2019, 5:30 PM
Council Chambers
150 Ski Hill Road
Breckenridge, Colorado

5:30pm - Call to Order of the September 3, 2019 Planning Commission Meeting; 5:30pm Roll Call Location Map
Approval of Minutes
Approval of Agenda

5:35pm - Public Comment On Historic Preservation Issues (Non-Agenda Items ONLY; 3-Minute Limit Please)

5:40pm - Preliminary Hearings

1. East Peak 8 Hotel (CK) PL-2018-0576; 1599 Ski Hill Road *Continued from first half* Grand Colorado on Peak 8 Building 3 Employee Housing Change has been moved to the September 17 Planning Commission Meeting as a Combined Hearing

6:10pm - Other Matters


1. Town Council Summary (Memo Only)

6:15pm - Adjournment

For further information, please contact the Planning Department at (970) 453-3160.

The indicated times are intended only to be used as guides. The order of the projects, as well as the length of the discussion for each project, is at the discretion of the Commission. We advise you to be present at the beginning of the meeting regardless of the estimated times.

Please note: This packet is split into two halves due to large file size. This is the SECOND HALF.

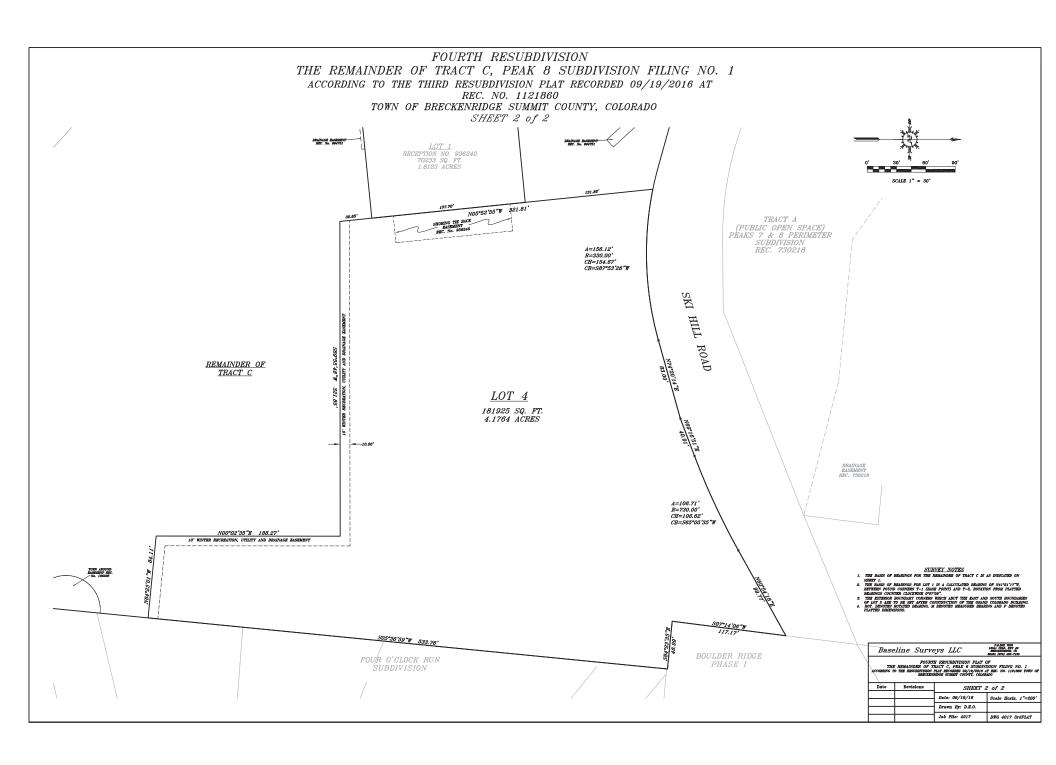



TOPOGRAPHIC MAP PROPOSED LOT 4 THE REMAINDER OF TRACT C, PEAK 8 SUBDIVISION FILING NO. 1 TOWN OF BRECKENRIDGE SUMMIT COUNTY COLORADO



TOPOGRAPHIC MAP PROPOSED LOT 4
THE REMAINDER OF TRACT C, PEAK 8 SUBDIVISION FILING NO. 1
TOWN OF BRECKENRIDGE
SUMMIT COUNTY COLORADO

Date	Revisions	ļ.			
		Date: 01-11-18	Scale Horiz. 1"=60'		
		Drawn By: D.E.O.			
		Drawn by: D.B.U.			
		Job File: 4017	DWG 4017 LOT 4 MAP		

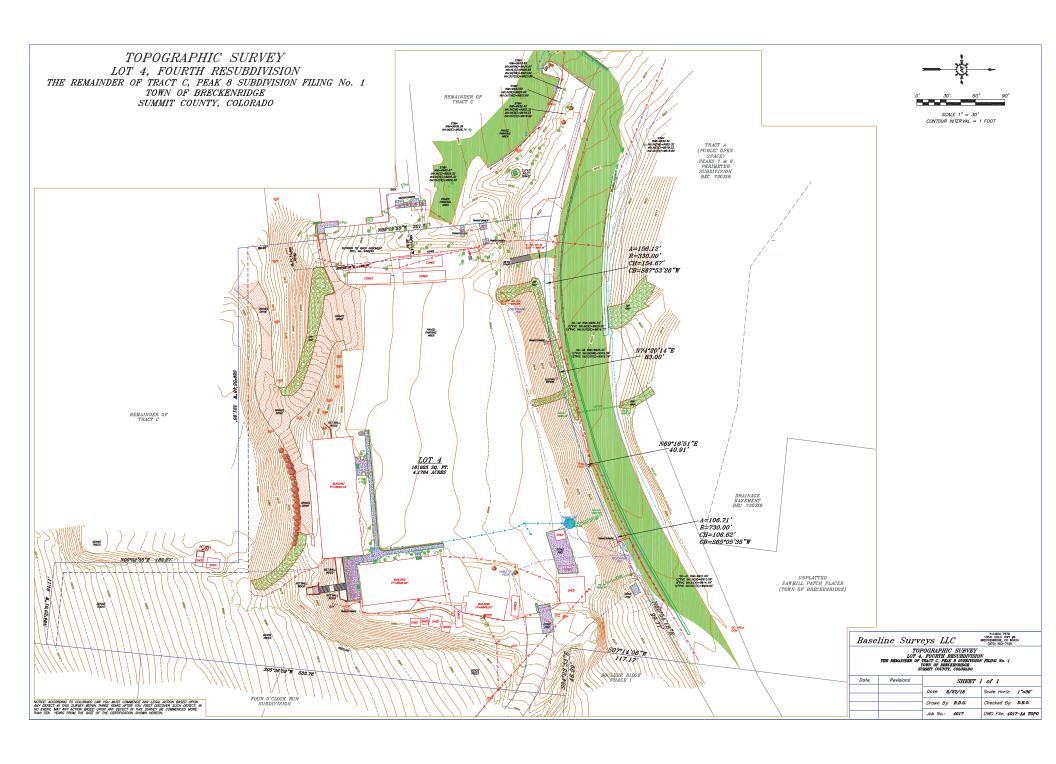

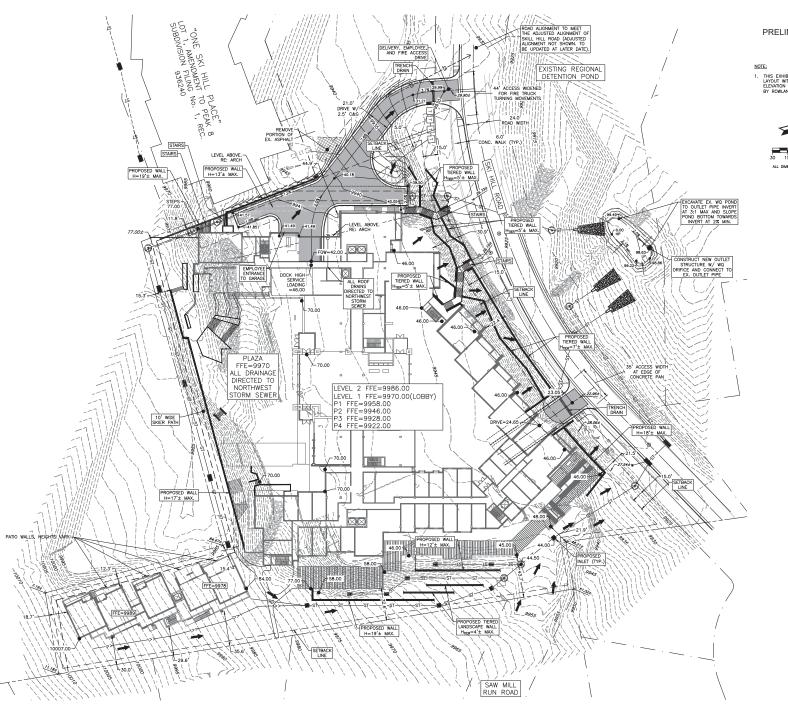

EP8 PRELIMINARY CONCEPT GRADING

 THIS EXHIBIT WAS CREATED FOR CONCEPT SITE LAYOUT WITH A POTENTIAL FINISHED FLOOR ELEVATION FOR EACH LEVEL AND LAYOUT PROVIDED BY ROWLAND BROUGHTON ON 07/09/19.





w. main st. 1830 blake en, oo 81611 denver, oo 802

Consultants:



suances and Revisions:

07.12.2019 TOB PLANNING - CLASS A 2ND PRELIMINARY



EAST PEAK 8

EAST PEAK 8 SKI HILL RD. BRECKENRIDGE, CO 80424


21729.00

SUCCE TITLE

CONCEPT GRADING PLAN

SCALE: PER PLAN

C1.0

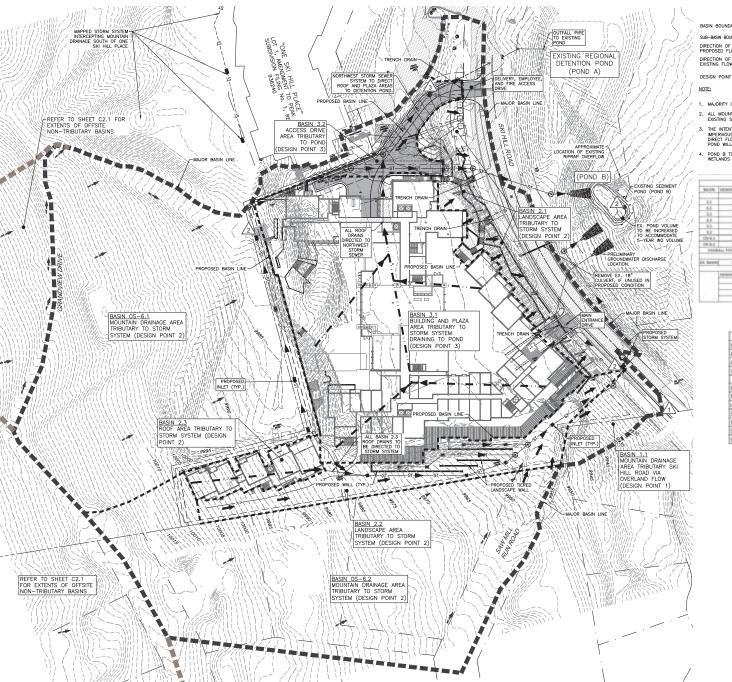

LEGEND

DIRECTION OF PROPOSED FLOW DIRECTION OF EXISTING FLOW

EP8 PRELIMINARY DRAINAGE CONCEPT

MAJORITY OF THE PROPOSED SITE DRAINAGE TO BE DIRECTED TO THE REGIONAL POND (POND A).

- ALL MOUNTAIN DRAINAGE LOCATED SOUTH OF THE PROPOSED SITE TO BE DIRECTED TO THE EXISTING SEDIMENT POND (POND B).
- THE INTENT OF THE DRAINAGE CONCEPT IS TO CAPTURE THE MAJORITY OF DEVELOPED AND IMPERVIOUS AREA WHERE PRACTICAL (ROOF DRAINS, AREA DRAINS, DECK DRAINS, ETC.) AND DIRECT FLOWS TO THE REGIONAL DETENTION PODD. FLOWS NOT DIRECTED TO THE REGIONAL POND WILL BE DIRECTED TO POND B, EXCEPT FOR THE SMALL AREA DELINEATED BY BASIN 1.1.
- POND B TO BE SIZED FOR SEDIMENT REMOVAL PRIOR TO DISCHARGE TO THE ADJACENT WETLANDS AREA.

			. 60	PIONAL N	mice.	SUBJECT	POWI:					
				more	ott dertir	W TOTAL	á					
94174	DESIGN Priore?	4400	Suit.	10	130	18	(38	1100	162	-9.6	1986	114.00
15.0		40	N-	Mile	1	-		1000	m.	179	1006	
1.1	1	0.21	28.2%	3.6	6.30	6.28	937	0.16	8.1	8.2	6.8	11.0
3.1.		0.41	11.7%	135	5.46	5.54	8.76	4.76	0.0	1.6	6.0	-6.6
3.4	- 1	8.94	1.76	.97	11.04	0.06	0.30	9.66	-0.1	0.0	0.4	1.6
23		3.11	95.0%	.12	1.0.79	1.79	4.77	8.01	31.8	114	0.8	
53		248	36.0%	1.8	4.78	4.79	4.77	0.00	1.0	14	-12	34.1
3.8		2.34	16.1%	-34	1.03	6.94	1.00	0.74	4.6	4.5	13.	3.7
126.63	1	3.11	149	1.8	0.00	31.96	3.76	A.M.	2.4	1.04	4.8	.39.5
2892		191	186	111.8	576	1.00	13.38	8.10	18.3	9.5	-1.6	. 84
2548	ALL TOTALS	10.46	16.0%	41.6	0.30	9.57	0.46	0.60	0.0	44-7	114	46.2
- 5.1				CROTA	el sann	100194	11	15.01				
ori, bushing		10.00	16.6%	21.3	3.09	100	3.36	(Add)	11	6.7	1.1	32,4
				V/PCSM1	OCHOR F	CONTR	mass.					
	PERMIT PROPERTY	AREA	Self-	16	-01	438	138	1386	.104	195	7526	7348
		.60		86/54	11111			1	CPL.	179	174	. 179
	. 1	0.21	16.2%	38 -	6.30	626	8.17	6.56	4.1	62	6.8.	8.6
	, a	1.44	10,7%	153	534	431	0.80	4.56	1.8	4.6	13	
		1.76	90.05	3.5	10.76	6.70	0.70	0.00	4.3	0.6	8.0	17.1

POND B	-	
EXISTING FOND CHARICTERISTICS		Der
Aree	0.021	AC (approximate
Average Depth:	3.06	FT
Volume	0.065	AC-FT
PROPOSED WATER QUALITY POND	Bert to record	
Tributay Area	7.48	AC -
impervioustess	0.107	%
5-year Tributary Flow	4.09	CFS
100-year Tributary Flow	23.40	CFS
5-year Detained Volume	0.017	ACFT.
Water Cuality Capture Volume	0.017	AC-FT



MARTIN/MARTIN

07.12.2019 TOB PLANNING - CLASS A 2ND PRELIMINARY

EAST PEAK 8

EAST PEAK 8 SKI HILL RD. BRECKENRIDGE, CO 80424

PROJECT NO: 21729.00

SHEET TITLE CONCEPT SITE DRAINAGE PLAN

SCALE: PER PLAN

C2.0





<u>LEGEND</u>

1



Issuances and Revisions: 07.12.2019 TOB PLANNING - CLASS A 2ND PRELIMINARY



EAST PEAK 8

EAST PEAK 8 SKI HILL RD. BRECKENRIDGE, CO 80424

PROJECT NO: 21729.00

SHEET TITLE: OFFSITE & SITE
CONCEPT DRAINAGE

PLAN

SCALE: PER PLAN C2.1

GENERAL NOTES

- 1. THE CONTRACTOR AND OWNER'S REPRESENTATIVE SHALL CONTACT THE LANDSCAPE ON THESE PLANS.
- 2. THESE PLANS SHALL NOT BE UTILIZED FOR CONSTRUCTION OR PERMITTING UNLESS
- STATED FOR SUCH USE IN THE TITLE BLOCK.

 DRAWINGS ARE INTENDED TO BE PRINTED ON 24" X 36" PAPER. PRINTING THESE

 DRAWINGS AT A DIFFERENT SIZE WILL IMPACT THE SCALE. VERIFY THE GRAPHIC SCALE BEFORE REFERENCING ANY MEASUREMENTS ON THESE SHEETS. THE RECIPIENT OF THESE DRAWINGS SHALL BE RESPONSIBLE FOR ANY ERRORS RESULTING FROM INCORRECT PRINTING FROM INCORRECT PRINTING, COPYING, OR ANY OTHER CHANGES THAT ALTER THE SCALE OF THE DRAWINGS
- VERIEV ALL PLAN DIMENSIONS PRIOR TO START OF CONSTRUCTION NOTIFY THE OWNER'S REPRESENTATIVE TO ADDRESS ANY QUESTIONS OR CLARIFY ANY DISCREPANCIES WRITTEN DIMENSIONS TAKE PRECEDENCE OVER SCALED DIMENSIONS.
- 6. SUBMIT A CHANGE ORDER FOR APPROVAL FOR ANY CHANGES TO WORK SCOPE
- RESULTING FROM FIELD CONDITIONS OR DIRECTION BY OWNER'S REPRESENTATIVE WHICH REQUIRE ADDITIONAL COST TO THE OWNER PRIOR TO PERFORMANCE OF WORK. THE CONTRACTOR SHALL PROVIDE A STAKED LAYOUT OF ALL SITE IMPROVEMENTS FOR INSPECTION BY THE OWNER'S REPRESENTATIVE AND MAKE MODIFICATIONS AS REQUIRED ALL LAYOUT INFORMATION IS AVAILABLE IN DIGITAL FORMAT FOR USE BY THE CONTRACTOR.
- 8 IE A GEOTECHNICAL SOILS REPORT IS NOT AVAILABLE AT THE TIME OF CONSTRUCTION NORRIS DESIGN RECOMMENDS A REPORT BE AUTHORIZED BY THE OWNER AND THAT ALL NORRIS DESIGN RECOMMENDS A REPORT BE AUTHORIZED BY THE OWNER AND THAT ALL RECOMMENDATIONS OF THE REPORT ARE FOLLOWED DURING CONSTRUCTION. THE CONTRACTOR SHALL USE THESE CONTRACT DOCUMENTS AS A BASIS FOR THE BID. IF THE OWNER ELECTS TO PROVIDE A GEOTECHNICAL REPORT. THE CONTRACTOR SHALL REVIEW THE REPORT AND SURMIT AN APPROPRIATE CHANGE ORDER TO THE OWNER'S
- REPRESENTATIVE IF ADDITIONAL COSTS ARE REQUESTED.

 9. CONTRACTOR SHALL CONFIRM THAT SITE CONDITIONS ARE SIMILAR TO THE PLANS, WITHIN TOLERANCES STATED IN THE CONTRACT DOCUMENTS. AND SATISFACTORY TO THE CONTRACTOR PRIOR TO START OF WORK. SHOULD SITE CONDITIONS BE DIFFERENT REPRESENTED ON THE PLANS OR UNSATISFACTORY TO THE CONTRACTOR, THE
- CONTRACTOR SHALL CONTACT THE OWNER'S REPRESENTATIVE FOR CLARIFICATION AND FURTHER DIRECTION.

 10. CONTRACTOR IS RESPONSIBLE TO PAY FOR, AND OBTAIN, ANY REQUIRED APPLICATIONS,
- PERMITTING, LICENSES, INSPECTIONS AND METERS ASSOCIATED WITH WORK.
- THE CONTRACTOR SHALL BE RESPONSIBLE FOR ANY FINES OR PENALTIES ASSESSED TO THE OWNER RELATING TO ANY VIOLATIONS OR NON-CONFORMANCE WITH THE PLANS, SPECIFICATIONS, CONTRACT DOCUMENTS, JURISDICTIONAL CODES, AND REGULATORY AGENCIES
- AGENCIES.

 12. THE CONTRACTOR SHALL BE RESPONSIBLE FOR COORDINATION OF ALL UTILITY LOCATES PRIOR TO ANY EXCAVATION. REFER TO ENGINEERING UTILITY PLANS FOR ALL PROPOSED UTILITY LOCATIONS AND DETAILS. NOTIFY OWNER'S REPRESENTATIVE IF EXISTING OR
- OTHER TECONITION AND DEFINISE, INVOITE OWNERS REFRESHMENT FOR EASING OR PROPOSED UTILITIES INTERFERE WITH THE ABILITY TO PERFORM WORK.

 13. UNLESS IDENTIFIED ON THE PLANS FOR DEMOLITION OR REMOVAL, THE CONTRACTOR IS RESPONSIBLE FOR THE COST TO REPAIR UTILITIES, ADJACENT OR EXISTING LANDSCAPE, ADJACENT OR EXISTING PAVING, OR ANY PUBLIC AND PRIVATE PROPERTY THAT IS DAMAGED BY THE CONTRACTOR OR THEIR SUBCONTRACTOR'S OPERATIONS DURING INSTALLATION, ESTABLISHMENT OR DURING THE SPECIFIED MAINTENANCE PERIOD. ALL DAMAGES SHALL BE REPAIRED TO PRE-CONSTRUCTION CONDITIONS AS DETERMINED BY OMMARCAS STRUCK OF MINIOR FOR A WORK OF A WORK
- LIMITS SHALL BE RETURNED TO THEIR ORIGINAL CONDITION AT THE CONTRACTOR'S EXPENSE. IN THE EVENT THE CONTRACTOR REQUIRES A MODIFICATION TO THE CONSTRUCTION LIMITS, WRITTEN PERMISSION MUST BE OBTAINED FROM THE OWNER'S REPRESENTATIVE PRIOR TO ANY DISTURBANCE OUTSIDE OF THE LIMITS OF WORK.
- 15. THE CONTRACTOR SHALL BE RESPONSIBLE FOR THE REPAIR OF ANY OF THEIR TRENCHES OR EXCAVATIONS THAT SETTLE.

 16. THE CONTRACTOR SHALL BE RESPONSIBLE TO PREPARE AND SUBMIT A TRAFFIC
- CONTROL PLAN TO THE APPROPRIATE JURISDICTIONAL AGENCIES AND THE OWNERS REPRESENTATIVE IF THEIR WORK AND OPERATIONS AFFECT OR IMPACT THE PUBLIC RIGHTS-OF-WAY, OBTAIN APPROVAL PRIOR TO ANY WORK WHICH AFFECTS OR IMPACTS THE PUBLIC RIGHTS-OF-WAY. THE CONTRACTOR SHALL BE RESPONSIBLE FOR ANY FINES OR PENALTIES ASSESSED TO THE OWNER RELATING TO THIS REQUIREMENT DURING THE

- 17 SIGHT TRIANGLES AND SIGHT LINES SHALL REMAIN LINORSTRUCTED BY FOUIPMENT. CONSTRUCTION MATERIALS, PLANT MATERIAL OR ANY OTHER VISUAL OBSTACLE DI
 THE CONTRACT PERIOD AND AT MATURITY OF PLANTS PER LOCAL JURISDICTIONAL REQUIREMENTS.
- NO PLANT MATERIAL OTHER THAN GROUND COVER IS ALLOWED TO BE PLANTED
 ADJACENT TO FIRE HYDRANTS AS STIPULATED BY JURISDICTIONAL REQUIREMENTS.
 COORDINATE SITE ACCESS, STAGING, STORAGE AND CLEANOUT AREAS WITH OWNER'S
- REPRESENTATIVE
- REPRESENTATIVE.

 20. CONTRACTOR IS RESPONSIBLE FOR PROVIDING TEMPORARY SAFETY FENCING AND BARRIERS AROUND ALL IMPROVEMENTS SUCH AS WALLS, PLAY STRUCTURES, EXCAVATIONS, ETC. ASSOCIATED WITH THEIR WORK UNTIL SUCH FACILITIES ARE COMPLETELY INSTALLED PER THE PLANS, SPECIFICATIONS AND MANUFACTURER'S RECOMMENDATIONS.
- 21. CONTRACTOR SHALL BE RESPONSIBLE FOR PROTECTION OF THEIR MATERIAL STOCK PILES AND WORK FROM VANDALISM, EROSION OR UNINTENDED DISTURBANCE DURING
- THE CONSTRUCTION PERIOD AND UNTIL FINAL ACCEPTANCE IS ISSUED.

 THE CONTRACTOR SHALL KNOW, UNDERSTAND AND ABIDE BY ANY STORM WATER POLLUTION PREVENTION PLAN (SWPP) ASSOCIATED WITH THE SITE. IF A STORM WATER POLLUTION PREVENTION PLAN IS NOT PROVIDED BY THE OWNER'S REPRESENTATIVE, REQUEST A COPY BEFORE PERFORMANCE OF ANY SITE WORK.

 23. MAINTAIN ANY STORM WATER MANAGEMENT FACILITIES THAT EXIST ON SITE FOR FULL
- FUNCTIONALITY. THE CONTRACTOR SHALL INSTALL AND MAINTAIN ANY NEW STORM. FOUNT IDMALITY. THE CONTRACTOR SHALL MISTALL AND MAINT AND ANY NEW STOKEN WATER MANAGEMENT FACILITIES THAT ARE IDENTIFIED IN THE SCOPE OF WORK TO FULL FUNCTIONALITY. THE CONTRACTOR SHALL BE RESPONSIBLE FOR ANY FINES OR PENALTIES ASSESSED TO THE OWNER FOR FAILURE TO MAINTAIN STORM WATER MANAGEMENT FACILITIES DURING THE CONTRACT PERIOD.
- 24. THE CONTRACTOR SHALL PREVENT SEDIMENT, DEBRIS AND ALL OTHER POLLUTANTS FROM EXITING THE SITE OR ENTERING THE STORM SEWER SYSTEM DURING ALL DEMOLITION OR CONSTRUCTION OPERATIONS THAT ARE PART OF THIS PROJECT. THE CONTRACTOR SHALL BE RESPONSIBLE FOR ANY FINES OR PENALTIES ASSESSED TO THE OWNER RELATING TO THESE REQUIREMENTS DURING THEIR CONTRACTED COURSE OF
- 25. THE CONTRACTOR SHALL BE RESPONSIBLE TO PREVENT ANY IMPACTS TO ADJACENT THE CONTRICTION SHALL BE RESPONSIBLE TO PREVENT ANY IMPACTS TO ADJACENT WATERWAYS, WETLANDS, OR OTHER ENVIRONMENTALLY SENSITIVE AREAS RESULTING FROM WORK DONE AS PART OF THIS PROJECT. THE CONTRACTOR SHALL BE RESPONSIBLE FOR ANY FINES OR PENALTIES ASSESSED TO THE OWNER RELATING TO THESE STANDARDS DURING THEIR CONTRACTED COURSE OF WORK.
- 26. THE CONTRACTOR AND/OR THEIR AUTHORIZED AGENTS SHALL INSURE THAT ALL LOADS OF CONSTRUCTION MATERIAL IMPORTED TO OR EXPORTED FROM THE PROJECT SITE SHALL BE PROPERLY COVERED TO PREVENT LOSS OF MATERIAL DURING TRANSPORT. TRANSPORTATION METHODS ON PUBLIC RIGHT-OF WAYS SHALL CONFORM TO IRANSFORTATION METHIODS ON PUBLIC MIGHT-OF WAYS SHALL CONFORM TO JURISDICTIONAL REQUIREMENTS. THE CONTRACTOR SHALL BE RESPONSIBLE FOR ANY FINES OR PENALTIES ASSESSED TO THE OWNER RELATING TO THESE REQUIREMENTS. 27. THE CLEANING OF EQUIPMENT IS PROHIBITED AT THE JOB SITE UNLESS AUTHORIZED BY
- THE OWNER'S REPRESENTATIVE IN A DESIGNATED AREA THE DISCHARGE OF WATER, WASTE CONCRETE, POLLUTANTS, OR OTHER MATERIALS SHALL ONLY OCCUR IN AREAS DESIGNED FOR SUCH USE AND APPROVED BY THE OWNER'S REPRESENTATIVE.
- 28. THE CLEANING OF CONCRETE EQUIPMENT IS PROHIBITED AT THE JOB SITE EXCEPT IN
- DESIGNATED CONCRETE WASHOUT AREAS. THE DISCHARGE OF WATER CONTAINING WASTE CONCRETE IN THE STORM SEWER IS PROHIBITED.

 29. THE USE OF REBAR, STEEL STAKES, OR STEEL FENCE POSTS TO STAKE DOWN STRAW OR HAY BALES OR TO SUPPORT SILT FENCING USED AS AN EROSION CONTROL MEASURE IS
- 30. LOCAL, STATE AND FEDERAL JURISDICTIONAL REQUIREMENTS, RESTRICTIONS OR PROCEDURES SHALL SUPERSEDE THESE PLANS, NOTES AND SPECIFICATIONS WHEN MORE STRINGENT. NOTIFY THE OWNER'S REPRESENTATIVE IF CONFLICTS OCCUR.

PLANTING SCHEDULE

RWO WOODS ROSE

KATHRYN DYKES POTENTILLA

PINK BEAUTY POTENTILLA

DOG BAILEY REDTWIG DOGWOOD

TBH TWINBERRY HONEYSUCKLE

VBE HIGHBUSH CRANBERRY

BTM BIG TUNA MUGO PINE

DGS DWARF GLOBE SPRUCE

MMP MINIATURE MUGO PINE

SMM SLOWMOUND MUGO PINE

TUFTED HAIR GRASS

INDIAN RICE GRASS

SISKIYOU BLUE IDAHO FESCUE

BUF BUFFALO JUNIPER

ESP FALSE SPIREA

KDE

EVERGREEN SHRUBS

ORNAMENTAL GRASSES THG

SIG

SYM. COMMON NAME

BOTANICAL NAME

POTENTILLA FRUTICOSA 'KATHRYN DYKES'

POTENTILLA FRUTICOSA PINK BEAUTY

SORRARIA SORRIFOLIA

CORNUS SERICEA 'BAILEYI'

LONICERA INVOLUCRATE

PINUS MUGO 'BIG TUNA

PINUS MUGO 'MOPS'

PICEA PUNGENS 'GLAUCA GLOBOSA

JUNIPEROUS SABINA 'BUFFALO'

PINUS MUGO 'SLOWMOUND'

DESCHAMPSIA CESPITOSA

ANDROPOGON GERARDI

ACHNATHERUM HYMENOIDES

FESTUCA IDAHOENSIS 'SISKIYOU BLUE

VIBURNUM EDULE

[DECIDUO	DUS TF	REES (184)		MRE	CREEPING OREGON GRAPE HOLLY	MAHONIA AQUIFOLIUM 'COMPACTA'
_	$\overline{}$	ASP	QUAKING ASPEN	POPULUS TREMULOIDES	PBS	CREEPING WESTERN SANDCHERRY	PRUNUS BESSEYI 'PAWNEE BUTTES'
	/	LAN	NARROWLEAF COTTONWOOD	POPULUS ANGUSTIFOLIA	KIN	KINNIKINNICK	ARCTOSTAPHLOS UVA-URSI
	•)	BPO	BALSAM POPLAR	POPULUS BALSAMIFERA	SMS	SILVER MOUND SAGE	ARTEMISIA SCHMIDTIANA
		MAL	THINLEAF ALDER	ALNUS INCANA TENUFOLIA	ALA	ALPINE ASTER	ASTER ALPINE 'GOLIATH'
~	(5)	RIB	RIVER BIRCH	BETULA NIGRA	HBL	BLUE HAREBELL	CAMPANULA ROTUNDIFOLIA
٠	γ	BTM	ROCK MOUNTAIN GLOW BIGTOOTH MAPLE	ACER GRANDIDENTATUM 'SCHMIDT'	LUP	LUPINE	LUPINUS SSP.
_		SPR	SPRING SNOW CRABAPPLE	MALUS 'SPRING SNOW'	MIN	MINT	MENTHA SSP.
		AMM	AMUR MAPLE	ACER GINNALA 'FLAME'	PWR	PINELEAF PENSTEMON	PENSTEMON PINIFOLIUS
		PKP	SCHUBERT CHOKECHERRY	PRUNUS VIRGINIANA 'SCHUBERT'	DCT	DWARF CREEPING THYME	THYMUS PRAECOX 'MINUS'
E	EVERGR	EEN T	REES (152)		WOO	WOOLLY THYME	THYMUS PRAECOX 'PSEUDOLANUGINOSUS'
7		FOX	BRISTLECONE PINE	PINUS ARISTATA	SIS	SNOW IN SUMMER	CERASTIUM TOMENTOSUM
(+)	ENG	ENGLEMANN SPRUCE	PICEA ENGELMANNII	GMS	GOLDMOSS-UTAH STONECROP	SEDUM ACRE EVERGREEN
`	(+)	SAF	SUBALPINE FIR	ABIES LASIOCARPA	DGC	DENVER GOLD COLUMBINE	AQUILEGIA CHRYSANTHA 'DENVER GOLD'
	\bigcirc	BES	BABY BLUE EYES COLORADO SPRUCE	PICEA PUNGENS 'BABY BLUE EYES'	ICQ	CHIEF QUINABY BEARDED IRIS	IRIS X GERMANICA 'CHIEF QUINABY'
		BCS	BAKERI COLORADO SPRUCE	PICEA PUNGENS 'BAKERI'	ICD	CHINA DRAGON BEARDED IRIS	IRIS X GERMANICA 'CHINA DRAGON'
		FBS	FAT ALBERT BLUE COLORADO SPRUCE	PICEA PUNGENS GLAUCA 'FAT ALBERT'	GAY	GAYFEATHER	LIATRIS SPICATA
		CBS	COLORADO BLUE SPRUCE	PICEA GLAUCA	PUT	PUSSYTOES	ANTENNARIA PARVIFOLIA
		DGF	DOUGLAS FIR	PSEUDOTUGA MENZIESI	RMC	ROCKY MOUNTAIN COLUMBINE	AQUILEGIA CAERULEA
		LIP	LIMBER PINE	PINUS FLEXILIS	DCB	DIXIE CHIP BUGLEWEED	AJUGA REPTANS 'DIXIE CHIP'
		CCF	WHITE FIR	ABIES CONCOLOR	DGP	PETITE DIANTHUS	DIANTHUS GRATIANOPOLITANUS 'PETITE'
		LOG	LOGPOLE PINE	PINUS CONTORTA	PMR	PURPLE MAZUS	MAZUS REPTANS
[DECIDUO	DUS SH	HRUBS		DWY	DWARF WOOLLY YARROW	ACHILLEA TOMENTOSA 'LEMON'
		CAC	PEKING COTONEASTER	COTONEASTER ACUTIFOLIA	ESS	SUNNY-SIDE UP FLEABANE	ERIGERON SCOPULINUS 'SUNNY SIDE UP'
		RBE	NATIVE RED BERRIED ELDER	SAMBUCUS PUBENS	WRA	WOOTON'S RAGWORT	SENECIO WOOTONII
		DAW	DWARF ARCTIC WILLOW	SALIX PURPUREA NANA			

R.O.W. TREE REQUIREMENTS

PERENNIALS & GROUNDCOVERS

REQUIRED QUANTITY (1 TREE EVERY 15 LF)	27
REQUIRED SIZES	MIN. 8' HEIGHT OR 3" CALIPER
PROVIDED QUANTITY (1 TREE EVERY 15 LF)	27
PROVIDED SIZES	MIN. 8' HEIGHT OR 3" CALIPER

SITE TOTALS

AREA	SQUARE FEET	% OF TOTAL
OPEN SPACE	94,502 SF	52%
IMPERVIOUS SURFACES	35,593 SF	20%
TOTAL SITE	181,925 SF	100%

*SNOW STACKING AREAS ARE NOT PROVIDED BECAUSE ALL DRIVES WILL BE HEATED.

rowland+broughton



409 Main Stree Suite 207

P.O. Box 2320 Erisco, CO 80443 P 970.485.4478 www.norris-design.com

EAST PEAK 8


EAST PEAK 8 1599 SKI HILL RD. BRECKENRIDGE, CO 80424

PROJECT NO:

SHEET TITLE: LANDSCAPE SCHEDULE

SCALE:

L-100

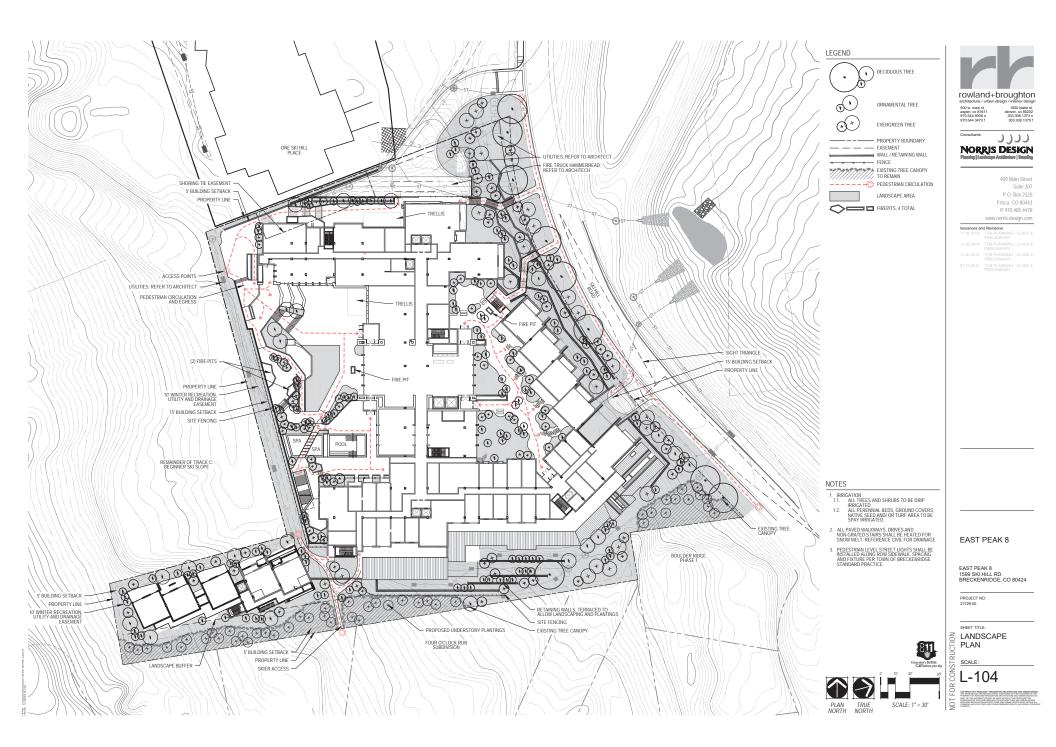





Consultants: NORRIS DESIGN Planeler II and same Architectura I Practice

409 Main Street Suite 207 P.O. Box 2320 Frisco, CO 80443 P 970.485.4478

Issuances and Revisions: 11.16.2018 TOB PLANNING - CLASS

12.05.2018 TOB PLANNING - CLASS / PRELIMINARY

07.13.2019 TOB PLANNING - CLASS PRFI IMINARY

EAST PEAK 8

EAST PEAK 8 1599 SKI HILL RD. BRECKENRIDGE, CO 80424

PROJECT NO: 21729.00

SHEET TITLE:

SILLUSTRATIVE
SITE PLAN

SCALE:

E L-105

PYRIGHT 2017 ROWLAND - BROUGHTON ARCHTECTURE AND URBAN DESIGN
IS RECEIVED TON AND DESIGN WITHOUT CONTAINED ON THE COCUMENT IS THE
OFF OF THE INFORMATION AND IS USED WITHOUT THE PRODUMENT IN
MISSISSION OF ROWLAND-BROUGHTON ARCHTECTURE AND URBAN DESIGN.

EP8 - SUPPORTING DOCUMENTS

2 N D P R E L I M I N A R Y C L A S S A S U B M I S S I O N

LOCATION: Breckenridge, Colorado

0 W N E R S: Lionheart Mountain Ventures LLC

ARCHITECTURE: Rowland+Broughton Architecture / Urban Design / Interior Design



THESE IMAGES AND IMAGES CONTAINED HEREIN ARE AN ARTIST'S REPRESENTATION INTENDED FOR VISUALIZATION ONLY AND MAY NOT DEPICT ALL CONDITIONS ACCURATELY. REFER TO DRAWINGS FOR ACCURATE DESIGN.



THESE IMAGES AND IMAGES CONTAINED HEREIN ARE AN ARTIST'S REPRESENTATION INTENDED FOR VISUALIZATION ONLY AND MAY NOT DEPICT ALL CONDITIONS ACCURATELY. REFER TO DRAWINGS FOR ACCURATE DESIGN.



THESE IMAGES AND IMAGES CONTAINED HEREIN ARE AN ARTIST'S REPRESENTATION INTENDED FOR VISUALIZATION ONLY AND MAY NOT DEPICT ALL CONDITIONS ACCURATELY. REFER TO DRAWINGS FOR ACCURATE DESIGN.



THESE IMAGES AND IMAGES CONTAINED HEREIN ARE AN ARTIST'S REPRESENTATION INTENDED FOR VISUALIZATION ONLY AND MAY NOT DEPICT ALL CONDITIONS ACCURATELY. REFER TO DRAWINGS FOR ACCURATE DESIGN.


EP8 CONTEXT VIEW - SKI SLOPE 2019.08.09



THESE IMAGES AND IMAGES CONTAINED HEREIN ARE AN ARTIST'S REPRESENTATION INTENDED FOR VISUALIZATION ONLY AND MAY NOT DEPICT ALL CONDITIONS ACCURATELY. REFER TO DRAWINGS FOR ACCURATE DESIGN.

GLAZING COMPARISON

EAST PEAK 8

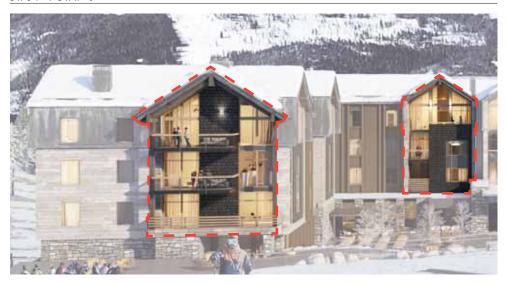

GRAND COLORADO



BUILDINGS VARY IN SHAPE AND FORM BUT SHARE SIMILAR PERCENTAGES OF GLAZING WITHIN MAIN BUILDING ELEMENTS.

AVERAGE GABLE - 36% GLAZING*

AVERAGE GABLE - 36% GLAZING

TOTAL 32 GABLES:

9 GABLES OF TYPE 1 - 38% GLAZING 11 GABLES OF TYPE 2 - 39% GLAZING 12 GABLES OF TYPE 3 - 32% GLAZING

*SINCE 1ST PRELIMINARY SUBMISSION, BUILDING GLAZING HAS BEEN <u>REDUCED BY ±8,000SF</u>

COLOR COMPARISON

EAST PEAK 8

ONE SKI HILL PLACE



ANALYSIS OF ARCHITECTURAL FORMS, FEATURES, AND MATERIALS SHOW SUBSTANTIAL SIMILARITIES AND CONTEXTUALLY APPROPRAITE DESIGN.

DARK ROOF FORMS

HEAVY ROOF BEAMS

SIMILAR ROOF SLOPES

DRAMATIC ROOF OVERHANGS

DISSOLVED GABLE SIDE WALLS

HEAVY TIMBER SIDING

DARK SHINGLES

COLOR COMPARISON

EAST PEAK 8

GRAND COLORADO



ANALYSIS OF ARCHITECTURAL FORMS, FEATURES, AND MATERIALS SHOW SUBSTANTIAL SIMILARITIES AND CONTEXTUALLY APPROPRAITE DESIGN.

HEAVY ROOF BEAMS

RUSTIC GABLE FORMS
SIMILAR ROOF SLOPES
DISSOLVED GABLE SIDE WALLS
MULTI-STORY STRUCTURAL ELEMENTS
METAL AND WOOD RAILINGS



STONE BASE















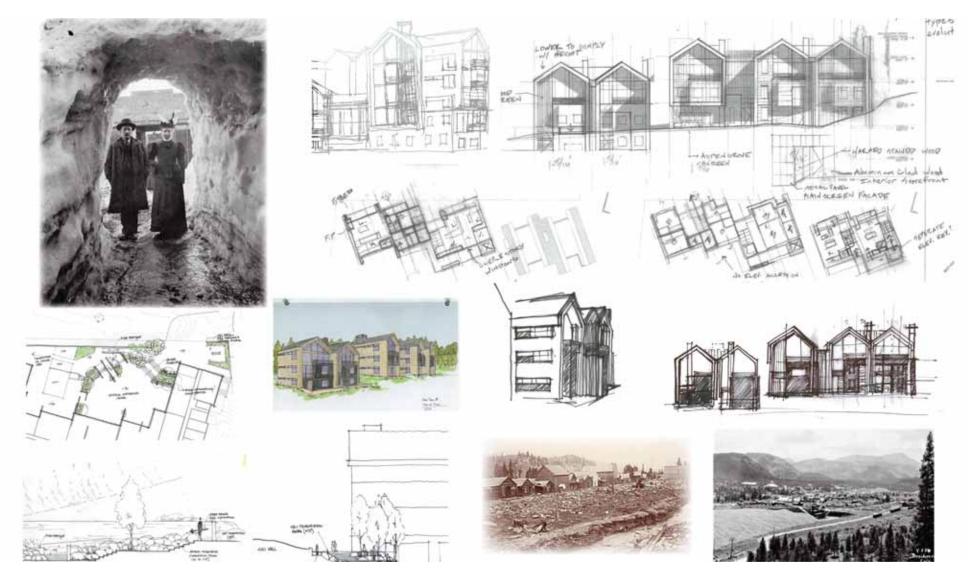

EP8

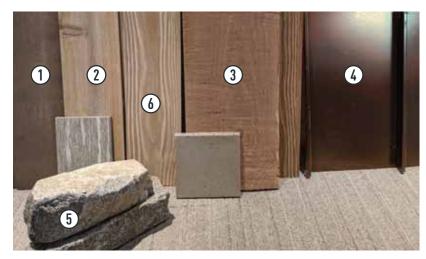

LEGEND

- 1 STAINED WOOD VERTICAL SIDING
- (2) HEAVY STACKED LOGS
- 3 ROUGH WOOD TIMBER SIDING
- 4 BRONZE STANDING SEAM ROOF
- (5) STONE BASE
- (6) ROUGH WOOD SCREEN

Peak 7 and 8 Master Plan


Design Standards (Extract)

- The architecture will present a transitional mountain style (between rustic and contemporary), through the use of authentic stone foundations, chimneys and other accent elements, interesting roof forms, large shaded windows, simple but strong detailing and a sense of informality. Natural and natural appearing materials, such as lap and shingle siding, board and batten siding, and real stone faced foundations, chimneys and other accent elements will enhance the character and blend with natural surroundings.
- Wood elements will be stained, with muted colors chosen from a natural palate of weathered browns and grays. Brighter hues may be used for elements such as windows and window trim. Design diversity will be achieved with each type of building, or cluster of buildings, each of which may have their own style to achieve such diversity. This is one of the few places in Breckenridge, where larger buildings can comfortably be in scale with the mountain backdrop and clearly be dominated by the surrounding natural mountain setting.




EP8 VIEW CORRIDORS 2019.08.09

As noted in the master plan, the fit test and view corridors graphics are conceptual in nature and not meant to determine actual building locations. Per the master plan, the most important elements depicted in the graphics are relationship of plaza areas, circulation and views of mountains and lifts. Plaza areas, circulation and views of lifts and mountains are improved from the original master plan and view corridors for the EP8 site with this proposal. An extensive south facing public plaza space engages guests and residents on the mountain side, creating an extension of the existing Peak 8 base area and expanding dining, lounging and apres experiences. Additional public plazas on the west and north sides of the property are designed for circulation and activation from adjacent One Ski Hill Place and Ski Hill Place property. Circulation is improved with the removal of Sawmill Road access and all vehicular traffic located in the underground garage. Service vehicle circulation is limited to the western side of the property which mirrors the service activities on the adjacent One Ski Hill Place property. Views to the mountain and lifts are maintained through balanced building mass reductions and height limitations, with a reduction in mass from the original property along the eastern property line.

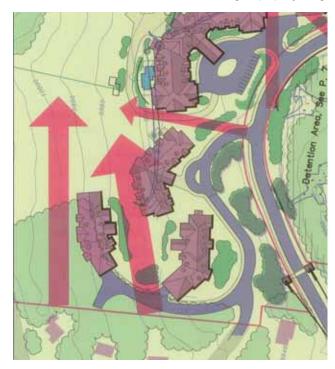

AMENDMENT TO MAY 2003 MASTER PLAN 15 AUGUST 2005

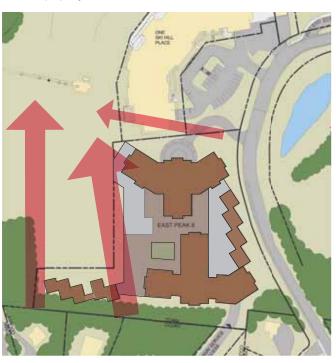

PREVIOUS PROPOSED SITE PLAN 04 JANUARY 2018



CURRENT PROPOSED SITE PLAN 13 NOVEMBER 2018









MASSING DEVELOPMENT 2019.08.09

LEGEND

REDUCTION AT 1ST CLASS-A PLANNING COMMISSION HEARING - 15 JANUARY 2019



MASSING DEVELOPMENT

2019.08.09

LEGEND

REDUCTION AT 1ST CLASS-A PLANNING COMMISSION HEARING - 15 JANUARY 2019



LEGEND

REDUCTION AT 1ST CLASS-A PLANNING COMMISSION HEARING - 15 JANUARY 2019




MASSING DEVELOPMENT

LEGEND

REDUCTION AT 1ST CLASS-A PLANNING COMMISSION HEARING - 15 JANUARY 2019



OPEN SPACE EXHIBIT

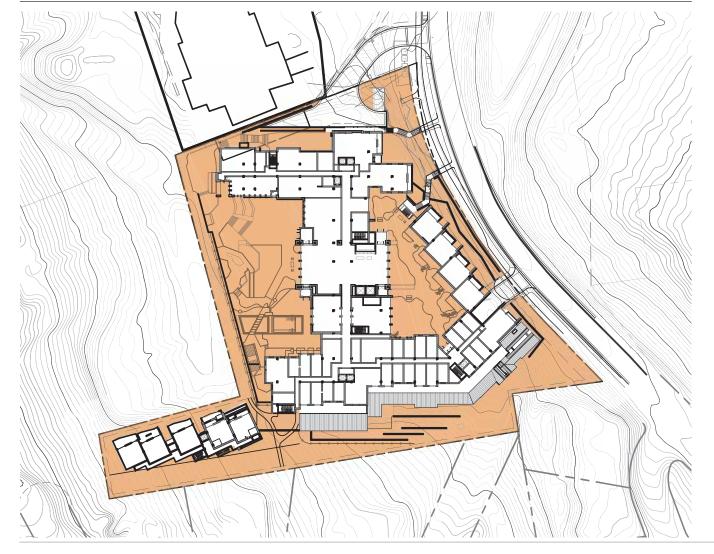

LEGEND




OPEN SPACE

OPEN SPACE CALCULATIONS TABLE

AREA	SQUARE FEET	% OF TOTAL SITE
OPEN SPACE	94,502	52%
TOTAL SITE	181,925	100%

NOTES:

1. NO SNOW STACK PROVIDED. ALL WALKS AND DRIVES TO BE SNOW MELT.

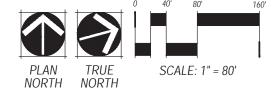



EAST PEAK 8
EAST PEAK 8
SKI HILL RD.
BRECKENRIDGE, CO 80424
07/13/19

SUPPORTING DOCUMENTATION

2ND PRELIMINARY PLANNING SUBMISSION - CLASS A





Consultants: NORRIS DESIGN Planning | Landscape Architecture | Possylvan

409 Main Street Suite 207 P.O. Box 2320 Frisco, CO 80443 P 970.485.4478 www.norris-design.com

EAST PEAK 8


EAST PEAK 8 1599 SKI HILL RD. BRECKENRIDGE, CO 80424

SHEET TITLE:

SILLUSTRATIVE
SITE PLAN


SCALE:


ੈ L-105

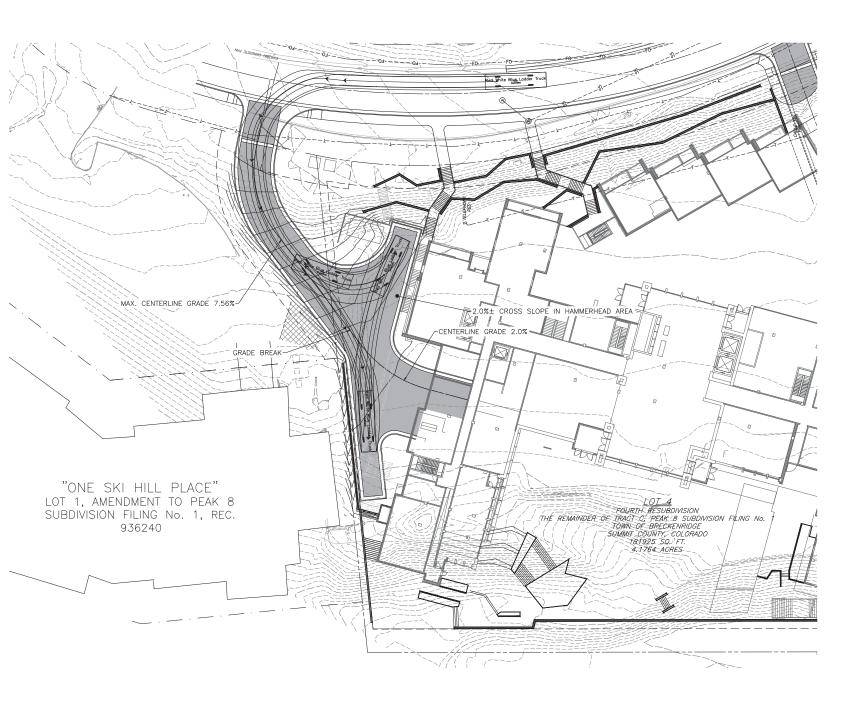

EP8 ACCESS EXHIBIT 07/12/2019

FIRE TRUCK MOVEMENT

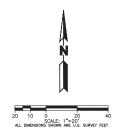

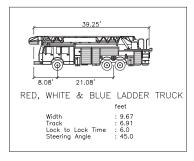

$\frac{\text{EXHIBIT A}}{\text{ACESS EASEMENT}}$ A PORTION OF THE REMAINDER OF TRACT C

AN ACCESS EASEMENT LOCATED ON THE REMAINDER OF TRACT C AS DEPICTED ON THE FOURTH RESUBDIVISION OF THE REMAINDER OF TRACT C, PEAK 8 SUBDIVISION, FILING NO. 1. A SUBDIVISION AS FILED FOR RECORD IN THE OFFICE OF THE CLERK AND RECORDER FOR SUMMIT COUNTY AT RECEPTION No. 1187721.

SAID EASEMENT BEING MORE PARTICULARLY DESCRIBED AS FOLLOWS:


BEGINNING AT A POINT ON THE WEST LINE OF LOT 4, OF SAID FOURTH RESUBDIVISION OF THE REMAINDER OF TRACT C, PEAK 8 SUBDIVISION FILING NO. 1, FROM WHICH THE NORTHWEST CORNER OF SAID LOT 4 BEARS N05°52'55"W, A DISTANCE OF 131.26 FEET. SAID POINT BEING IN FACT THE TRUE POINT OF BEGINNING.

THENCE CONTINUING FOR THE FOLLOWING 7 COURSES:

- 1) S84°26'00"W, ALONG THE SOUTHERLY LINE OF SAID REMAINDER OF TRACT C, A DISTANCE OF 7.76 FEET.
- 2) N37°17'30"W, A DISTANCE OF 84.76 FEET.
- 3) 78.27 FEET ALONG THE ARC OF A CURVE TO THE RIGHT, HAVING A RADIUS OF 91.00 FEET, AND A CHORD WHICH BEARS N12°39'04"W, A DISTANCE OF 75.88 FEET.
- 4) N11°59'26"E, A DISTANCE OF 6.14 FEET TO A POINT ON THE SOUTHERLY RIGHT OF WAY OF SKI HILL ROAD.
- 5) S74°20'53''E, ALONG SAID RIGHT OF WAY FOR SKI HILL ROAD, A DISTANCE OF 38.85 FEET.
- 6) THENCE; CONTINUING ALONG SAID RIGHT OF WAY, 24.24 FEET ON THE ARC OF A CURVE TO THE LEFT, HAVING A RADIUS OF 330.00 FEET, AND A CHORD WHICH BEARS S76°27'09"E, A DISTANCE OF 24.23 FEET, TO SAID NORTHWEST CORNER OF SAID LOT 4.
- 7) THENCE; S05°52'55"E, ALONG SAID WESTERLY LINE OF SAID LOT 4, A DISTANCE OF 131.26 FEET TO THE POINT OF BEGINNING.

DESCRIBED PARCEL CONTAINING 6504 SQUARE FEET, OR 0.1493 ACRES, MORE OR LESS.


Baseline Surveys LLC P.O. 7578 Breckenridge CO 80424 P:\4017 Construction Easements

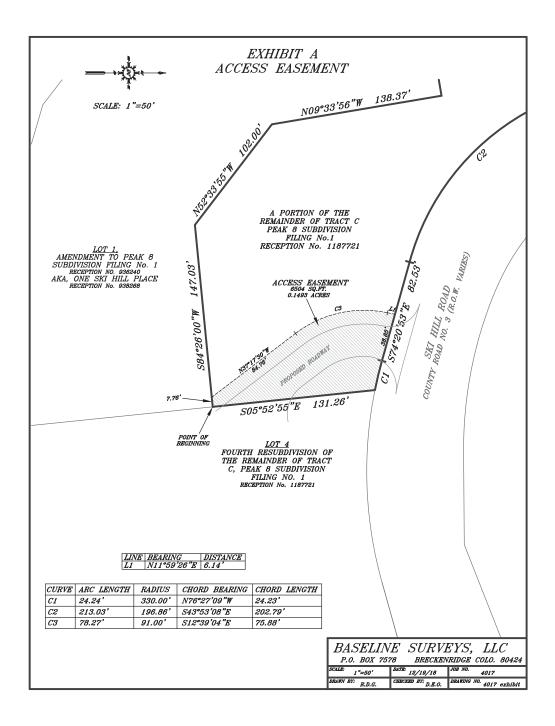

National Flood Hazard Layer FIRMette FEMA SUMMIRCOUNTY 080290 T6S R78W,S35 TOWN OF BRECKENRIDGE AREA OF MINIMAL FLOOD HAZARD East Peak 8 - Ski Hill Road Area of Minimal Flood Hazard Zone - X 08117C0481E eff. 11/16/2011 SUMMIT COUNTY T7S F78W,S2 1:6,000 250 500 1,000 1,500 2,000

Legend

ME FIS REPORT FOR DETAILED LEGEND AND INDEX MAP FOR FIRM PANEL LAYOUT

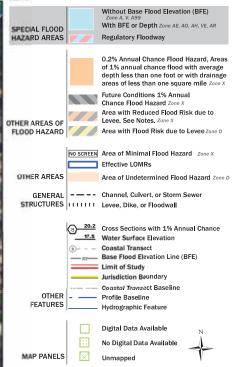



The pin displayed on the map is an approximate point selected by the user and does not represent an authoritative property location.


This map complies with FEMA's standards for the use of a fital flood maps if it is not void as described below. The basemap shown complies with FEMA's basemap curacy standards

The flood hazard information is derived directly from the authoritative NFH. Web services provided by FFMA. This map wis exported on 11/12/2018 at 4:16:00 PM and does not reflect changes or amendments subsequent to this date and time. The NFHL and effective information may change or come superseded by new data over time.

This map image is void if the one or more of the following map ements do not appear: basemap imagery, flood zone labels, gend, scale bar, map creation date, community identifiers, FIRM panel number, and FIRM effective date. Map images for umapped and unmodernized areas cannot be used for gulatory purposes.

THE FOUR O'CLOCK

A SUBDIVISION OF PORTIONS OF SECTION 36-6-78 AND SECTION 1-7-78, BEING PORTIONS OF THE TYRA PLACER MIN. SUR. NO. 13343, AND THE SAW MILL PATCH PLACER MIN. SUR. NO. 2533 ALL IN THE SPAULDING MINING DISTRICT

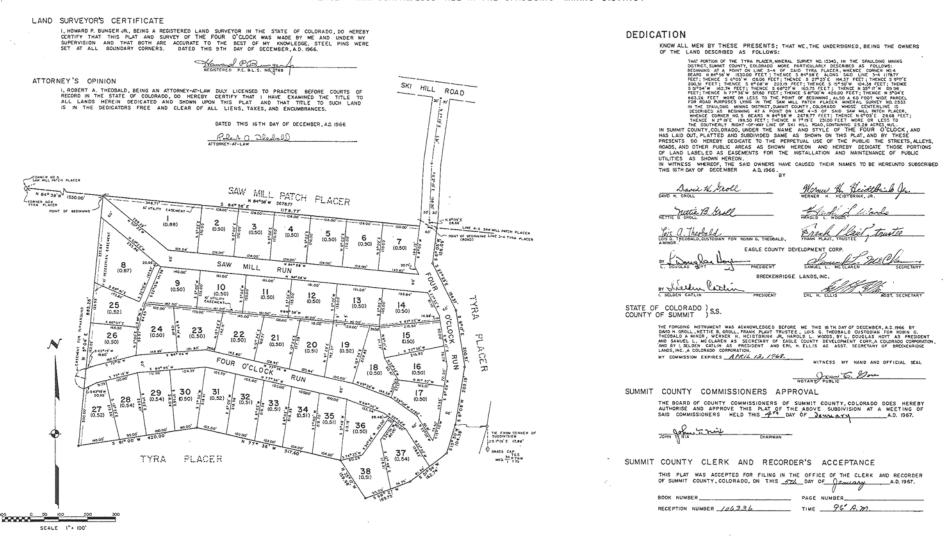

RICHARDS-BUNGER-HUFFSTUTLER, ENGINEERS, INC. 9465 WEST COLFAX AVENUE DENVER, COLDRADO



August 27 Town Council Meeting





Welcome to the newsletter summarizing The Town of Breckenridge's latest Council Meeting. Our goal is to provide our citizens with thorough and reliable information regarding Council decisions. We welcome any feedback you may have and hope to see you at the meetings.

Managers Report


Fiber9600

• The fiber construction continues to progress on schedule. The Xcel joint trenching is underway on Wellington Rd and cable pulling and splicing has also started through the project areas. Remaining work on the project includes the highway 9 crossings at Huron Rd and Airport Rd and the hut site build. The work within the roadways should be completed in September, with the pulling, splicing, and hut site work continuing through the fall.

• There will be an informational panel and forum at Town Hall on September 12 at 5:30 pm titled "Fiber and the Future of Breckenridge" where experts from the state and national level will come to talk about the future of fiber infrastructure in Breckenridge, Colorado, and the nation. This educational event is for those who want to better understand this technology and the other communities that are pursuing it.

Wayfinding Package

- The Town's Wayfinding Project, led by Walker Consultants and Norris Design, began in 2017 with the
 design and installation of digital message signs (DMS) at the south and north ends of town. This
 second phase of the project has expanded to include additional vehicular wayfinding, as well as
 pedestrian level signage.
- The goal of the Wayfinding Project is to direct visitors to key destinations and parking opportunities throughout the town in a safe and effective manner, reduce traffic congestion and circling, and evolve the design aesthetic of the signage to incorporate the new Town logo.

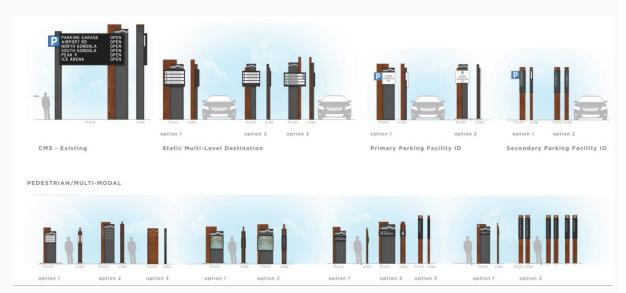

Finance

July is largely reflective of June tax collections. We are approximately \$1.2M over 2019 budgeted revenues in the Excise fund. This is mostly due to sales tax being \$650k over budget and Real Estate Transfer Tax up \$369k over budget. Sales Tax is \$849k ahead of prior year; RETT is up \$104k over prior year.

Other Presentations

Proposed Short Term Rental Ordinance Changes

- Staff suggested a flat annual demand fee that can accomplish goal of effectively charging STR units a
 higher water rate for their business use of Town water & to account for spike in winter demand levels.
 A flat fee will reach all STR licensed properties on an equitable basis. Council did not want to
 pursue the water issue.
- The ordinance addresses:
 - Occupancy set at 2 persons per bedroom plus 4, with the exception of studios, which shall be considered 0 bedrooms and as such allowed 4 persons.
 - Advertisements are required to display the occupancy limit as well as business license (BOLT) number.
- Finance will amend business license invoices and the business licenses form for accommodations
 units to show the number of bedrooms for a particular unit per our records. This will eliminate any
 confusion as far as what occupancy number the licensee should post on their advertisement per (2)
 above. Finance will base the number of bedrooms off of the County's Assessors Office.

Annual Parking Report

- Revenue increased by 35% in the 2018/19. The majority of the increase can be attributed to the following:
 - Increase in overnight parking rates \$25/night on weekends at the Ice Rink and \$10/night on
 - weekends at the Satellite Lot.
 - O Addition of S. Gondola as a pay lot in the summer for the first time.
 - The change in locals' appreciation in May from all free to only the lots being free.
 - Increase in rates on S. Main Street and the Flot. These changes accounted for roughly \$398,338 of the increase or 80% of the increase.
- Length of stay in 2018/2019 was comparable with 2017/2018. There were four lots that saw some increase in stays of 5 hours or more.
 - o Ice House Stays of at least 5 hours increased from 8 to 10 percent.
 - o Tonopah Stays of at least 5 hours increased from 6 to 8 percent.
 - Wellington Stays of at least 5 hours increased from 29 to 38 percent.
 - Tiger Dredge Stays of at least 5 hours increased from 27 to 34 percent.
- All of the lots see a significant decrease in stays after the third hour except for the FLOT,
 Tiger Dredge, and Wellington lots which are designed for longer stays

- Recommendation: In order to discourage long-term parking in Tonopah and Ice House, staff recommends increasing the pay rates on an escalating schedule as noted in the attached proposed rate schedule.
- The overnight parking rate increased from \$5 to \$15 in 2015/2016 in the Ice Rink. The overnight rate increased on weekends this year from \$15 to \$25/night.
- The average number of vehicles parked at the Ice Rink overnight has increased from 22 to 34 over the last three winters – an increase of 55%. Weekends have seen an increase of 50% in the same period.
- The average number of vehicles parked at the Airport lot overnight has increased from 30 to 83 over the last four winters – an increase of 175%. Weekends have seen an increase of 172% in the same period. Through pricing, we have been able to keep the majority of overnight vehicles parked in the Airport Lot. However, we have not been able to limit the total number of extra vehicles in need of overnight parking.
- On average, the Town provided 118 combined overnight parking spaces per night in 2018/2019. That number increases to 185 on weekends.
- January 12, 2019, was the busiest night of overnight parking with 341 paid vehicles when combining Airport Lot and Ice Rink.
- Recommendation: In order to further discourage overnight parking in the Ice Rink lot, staff recommends increasing the pay rates.
- There was an overall increase of 8% in the traffic volume on Highway 9 and increase of 2% on I-70 in 2018/2019 compared to last season.

CITATION COUNT									
	For the period of May-April								
	2013-2014 2014-2015 2015-2016 2016-2017 2017-2018 2018-2019								
Warnings/Voids 1015 1227 1325 4427 132						7175			
Citations 5384 6304 6763 3171 4086						3976			
Total	6399	7531	8088	7598	17307	11151			

CITATION COUNT BY STATUS									
	For the period of May-April								
STATUS 2013-2014 2014-2015 2015-2016 2016-2017 2017-2018 2018-2019									
PAID	4747	5498	5223	2690	3066	2609			
NOT PAID	637	806	1031	481	1020	1367			
COLLECTION RATE	88%	87%	85%	85%	75%	66%			
APPEAL ACCEPTED	NA	NA	NA	NA	371	301			
(not included in Paid or Unpaid)					0,1	551			

TOP VIOLATIONS (includes warnings/voids)	2017-2018	TOP VIOLATIONS (includes warnings/voids)	2017-2018
Payment Required	13,255	Payment Required	8014
Signs Prohibit	1,729	Signs Prohibit	1757
2-6 AM	581	2-6 AM	217
2hr Violation	403	2hr Violation	189
Obstructing Traffic	376	Delivery Zone	164
Residential Street	147	Obstructing Traffic	162

Blue River Access Control Plan Update

- Four trail design typical sections are being utilized in the conceptual trail design. The conceptual trail
 design is nearing completion, and will be presented in detail at the next Open House. The trail is
 being proposed along the west side of the highway. Working south to north, the following
 describes how each of the typical sections will be applied along the corridor:
 - Widened shoulders (5' wide) will be proposed on CO 9 from the Park County Line to Mark Court
 - A Shared Use Sidepath (10-12' paved pathway with a 5' separation from the travel lane) will be proposed from Quandary Drive to Green Mountain Drive
 - A Shared Use Trail (12' paved pathway with a 6' or greater separation from the travel lane on CO 9) will be proposed from Mark Court to Quandary Drive, and from Green Mountain Drive to River Park Drive

 A widened Sidewalk (10-12' wide off the edge of the travel lane on CO 9) will be proposed from River Park Drive to Boreas Pass Road. An option will be presented to extend the widened sidewalk south of River Park Drive.

Peak 7 Chairlift Proposal

On August 21 the Council conducted a site visit to the proposed alignment of the new chairlift
and visited the top and bottom terminal locations. Representatives of the US Forest Service and
the Breckenridge Ski Resort were in attendance at the site visit.

Regular Council Meeting

Legislative Review

- Minimum Tobacco Product Age Ordinance (Second Reading): This ordinance raises the
 consumption age of tobacco and nicotine products to 21 years old in the Town of Breckenridge.
 (Passed 7-0)
- Retail Tobacco Business Licensing Ordinance (Second Reading): This ordinance will allow the
 Town Clerk to license all retailers selling tobacco products, including all nicotine products, smoking
 devices, and any accessory used for the consumption of tobacco products. (Passed 7-0).
- Sale of Dogs and Cats from Inhumane Breeding Facilities Ordinance (First Reading): Several
 weeks ago Council was asked to consider enacting an ordinance that would prohibit the sale of dogs
 and cats produced in inhumane breeding facilities. The ordinance prohibits any business from offering
 for sale dogs and catsfrom an inhumane breeding facility. The term "offer for sale" includes sale,
 delivering, offering for sale, barter, auction, or in any way disposing of a dog or cat. (Passed 7-0)
- Cucumber Creek Estates Drainage Easement (First Reading): Cucumber Creek Associates, LLC., the beneficiary of an existing Drainage and Detention Pond Easement on a Town owned Open Space parcel known as Christie Heights Subdivision #2, Tract A, has requested a relocation of the easement. This easement was dedicated on the now designated Open Space lot in 2001 with a replat of a portion of the original Christie Heights Subdivision, which included land where the Cucumber Creek Estates Subdivision and the Nordic Center are located. The existing easement is for the benefit of the Cucumber Creek Estates Subdivision only. (Passed 7-0)
- GIS Resolution (Resolution): Intergovernmental Agreement (IGA) facilitate tshe towns of
 Breckenridge, Frisco, and Silverthorne to share mapping software. Environmental Systems Research
 Institute, Inc. ("ESRI") is a provider of Geographic Information Software ("GIS") and has created a

Regional Government Enterprise License Agreement ("ELA") intended for a group of small towns with a combined population under 25,000 to allow the towns to work together and enter into a single software licensing agreement. (Passed 7-0)